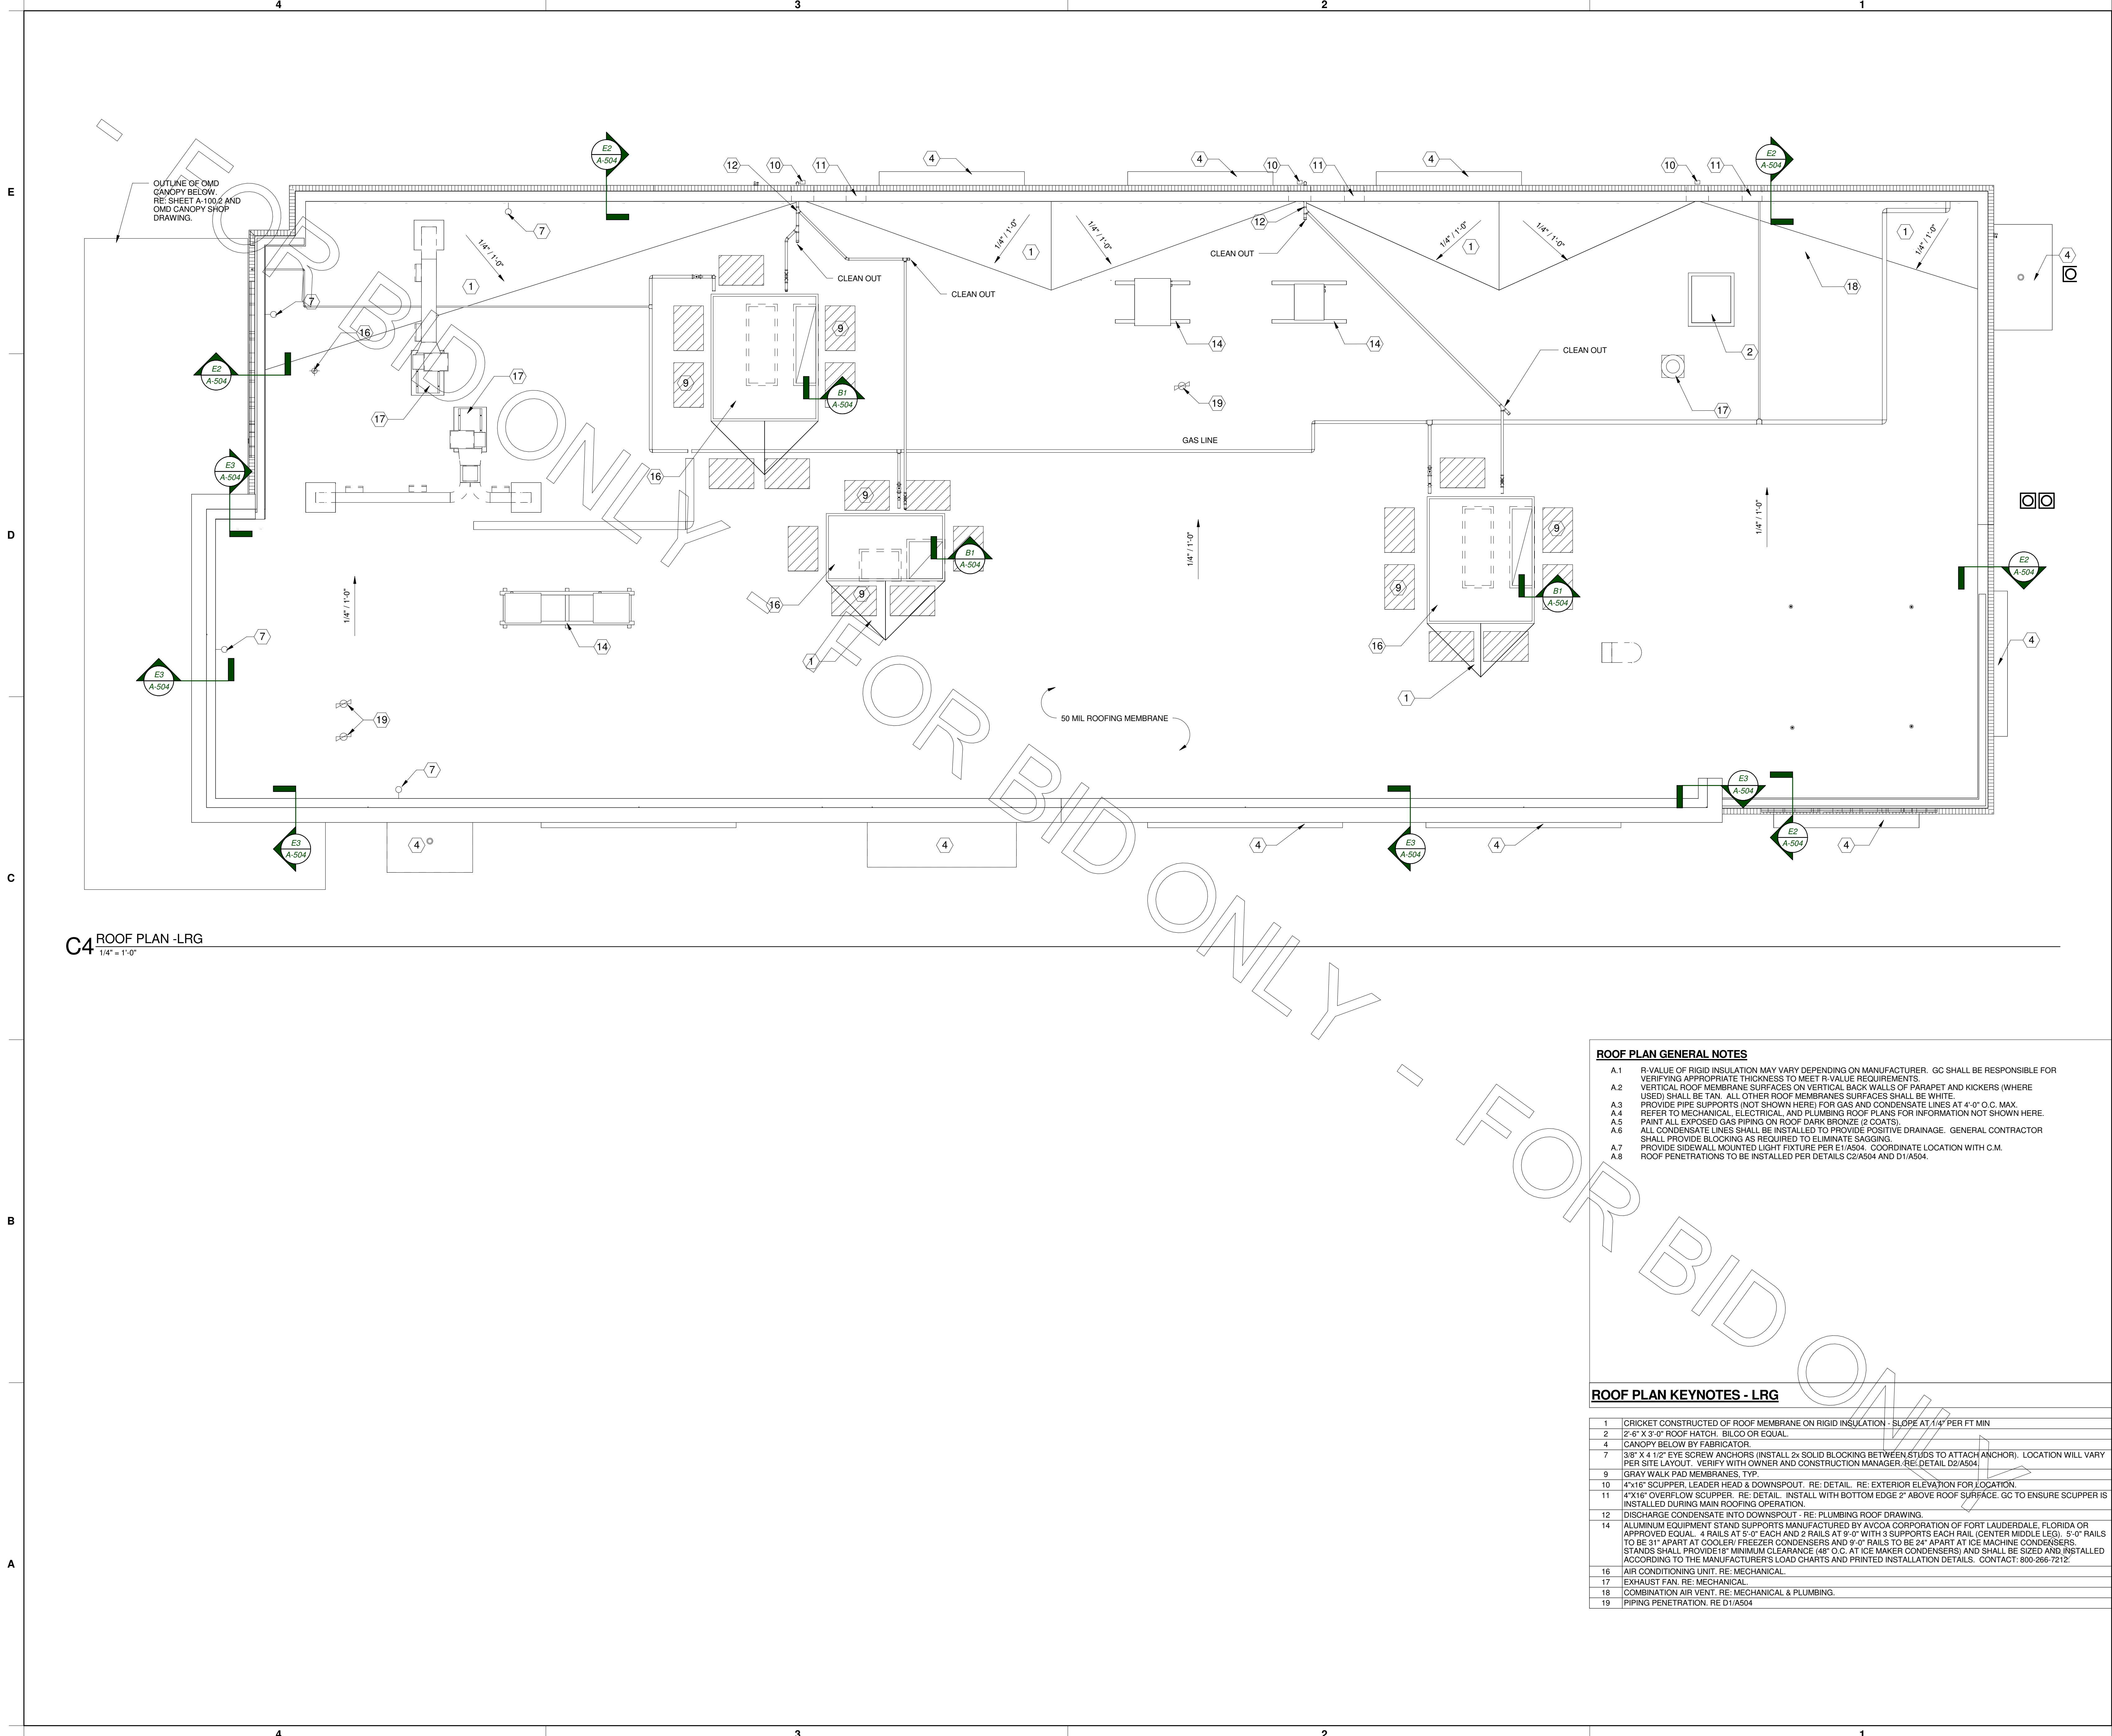


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C4 ROOF PLAN - LRG
1/4" = 1'-0"

ROOF PLAN GENERAL NOTES

- A.1 R-VALUE OF RIGID INSULATION MAY VARY DEPENDING ON MANUFACTURER. GC SHALL BE RESPONSIBLE FOR VERIFYING APPROPRIATE THICKNESS TO MEET R-VALUE REQUIREMENTS.
A.2 VERTICAL ROOF MEMBRANE SURFACES ON VERTICAL BACK WALLS OF PARAPET AND KICKERS (WHERE USED) SHALL BE TAN. ALL OTHER ROOF MEMBRANE SURFACES SHALL BE WHITE.
A.3 PROVIDE PIPE SUPPORTS (NOT SHOWN HERE) FOR GAS AND CONDENSATE LINES AT 4'-0" O.C. MAX. REFER TO MECHANICAL, ELECTRICAL, AND PLUMBING ROOF PLANS FOR INFORMATION NOT SHOWN HERE.
A.4 PAINT ALL EXPOSED GAS PIPING ON ROOF DARK BRONZE (2 COATS).
A.5 ALL CONDENSATE LINES SHALL BE INSTALLED TO PROVIDE POSITIVE DRAINAGE. GENERAL CONTRACTOR SHALL PROVIDE BLOCKING AS REQUIRED TO ELIMINATE SAGGING.
A.6 PROVIDE SIDEWALL MOUNTED LIGHT FIXTURE PER E1/A504. COORDINATE LOCATION WITH C.M.
A.7 ROOF PENETRATIONS TO BE INSTALLED PER DETAILS C2/A504 AND D1/A504.

ROOF PLAN KEYNOTES - LRG

1	CRICKET CONSTRUCTED OF ROOF MEMBRANE ON RIGID INSULATION - SLOPE AT 1/4" PER FT MIN
2	2'-6" X 3'-0" ROOF HATCH. BILCO OR EQUAL.
4	CANOPY BELOW BY FABRICATOR.
7	3/8" X 4 1/2" EYE SCREW ANCHORS (INSTALL 2x SOLID BLOCKING BETWEEN STUDS TO ATTACH ANCHOR). LOCATION WILL VARY PER SITE LAYOUT. VERIFY WITH OWNER AND CONSTRUCTION MANAGER. RE: DETAIL D2/A504
9	GRAY WALK PAD MEMBRANES, TYP.
10	4"x16" SCUPPER, LEADER HEAD & DOWNSPOUT. RE: DETAIL. RE: EXTERIOR ELEVATION FOR LOCATION.
11	4"x16" OVERFLOW SCUPPER. RE: DETAIL. INSTALL WITH BOTTOM EDGE 2" ABOVE ROOF SURFACE. GC TO ENSURE SCUPPER IS INSTALLED DURING MAIN ROOFING OPERATION.
12	DISCHARGE CONDENSATE INTO DOWNSPOUT - RE: PLUMBING ROOF DRAWING.
14	ALUMINUM EQUIPMENT STAND SUPPORTS MANUFACTURED BY AVCOA CORPORATION OF FORT LAUDERDALE, FLORIDA OR APPROVED EQUAL. 4 RAILS AT 9'-0" EACH AND 2 RAILS AT 9'-0" WITH 3 SUPPORTS EACH RAIL (CENTER MIDDLE LEG). 5'-0" RAILS TO BE 31" APART AT COOLER, FREEZER CONDENSERS AND 9'-0" RAILS TO BE 24" APART AT ICE MACHINE CONDENSERS. STANDS SHALL PROVIDE 18" MINIMUM CLEARANCE (48" O.C. AT ICE MAKER CONDENSERS) AND SHALL BE SIZED AND INSTALLED ACCORDING TO THE MANUFACTURER'S LOAD CHARTS AND PRINTED INSTALLATION DETAILS. CONTACT: 800-266-7212.
16	AIR CONDITIONING UNIT. RE: MECHANICAL.
17	EXHAUST FAN. RE: MECHANICAL.
18	COMBINATION AIR VENT. RE: MECHANICAL & PLUMBING.
19	PIPING PENETRATION. RE: D1/A504



Chick-fil-A

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REVISION SCHEDULE

NO.	DATE	DESCRIPTION

CONSULTANT PROJECT # 2017.0149
PRINTED FOR Bid
DATE November 20, 2017
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SHEET
ROOF PLAN

SHEET NUMBER
A-230L